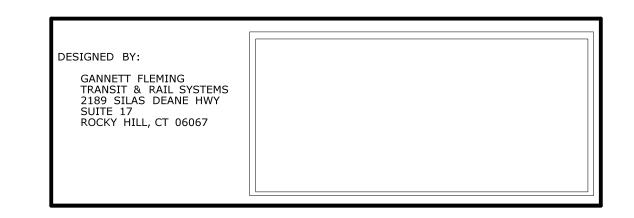
O5 - GROUNDING & BONDING INDEX OF DRAWINGS

DRAWING NUMBER	DRAWING TITLE	DRAWING NUMBER	DRAWING TITLE	
IND-01	GROUNDING & BONDING INDEX OF DRAWINGS			
BBG-01	GROUNDING & BONDING GENERAL NOTES, LEGEND, AND ABBREVIATIONS			
BBG-02	GROUNDING & BONDING ROUTE 349 SOUTHBOUND BRIDGE NO. 03330			
BBG-03	GROUNDING & BONDING ROUTE 349 NORTHBOUND BRIDGE NO. 03331			
BBG-04	GROUNDING & BONDING STAGING PLANS SHEET 1 OF 2			
BBG-05	GROUNDING & BONDING STAGING PLANS SHEET 2 OF 2			
BBG-06	GROUNDING & BONDING ASSEMBLY DETAILS SHEET 1 OF 2			
BBG-07	GROUNDING & BONDING ASSEMBLY DETAILS SHEET 2 OF 2			
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90% SUBMISSION 03/09/2016

					DES:
				THE INFORMATION, INCLUDING ESTIMATED	
				QUANTITIES OF WORK, SHOWN ON THESE SHEETS IS BASED ON LIMITED	CHE
				INVESTIGATIONS BY THE STATE AND IS IN NO WAY WARRANTED TO INDICATE	
				THE CONDITIONS OF ACTUAL QUANTITIES	
				OF WORK WHICH WILL BE REQUIRED.	
REV.	DATE	REVISION DESCRIPTION	SHEET NO.	Plotted Date: 3/1/2016	

AJM

HECKED BY:

WJS/WWF

SCALE AS NOTED



GANNETT FLEMING

APPROVED BY:

RECONSTRUCTION OF ROUTE 349 NB AND SB OVER AMTRAK RAILROAD

GROTON	PROJECT NO. 058-33	
GROUNDING & BONDING	IND-01	
INDEX OF DRAWINGS	SHEET NO.	

GENERAL NOTES:

- 1. GROUNDING AND BONDING WORK WILL BE PAID UNDER ITEM #1015034A GROUNDING AND BONDING ALL GROUNDING AND BONDING WORK SHOWN WILL BE DONE BY THE CONTRACTOR, EXCEPT FOR THE CONNECTIONS OF THE NEW BONDING LOOP TO THE EXISTING RAILROAD STATIC WIRE. THOSE CONNECTIONS WILL BE DONE BY AMTRAK.
- 2. THE GROUNDING AND BONDING STAGING PLANS SHOW THE SUGGESTED SEQUENCING OF THE GROUNDING AND BONDING WORK AND ARE NOT NECESSARILY TO BE USED AS THE CONSTRUCTION SEQUENCING AND STAGING PLANS FOR THE BRIDGE REPLACEMENT WORK. THE BRIDGE CONSTRUCTION SEQUENCING AND STAGING PLANS ARE SHOWN ELSEWHERE IN THE PLANS AND SPECIFICATIONS.
- THE CONTRACTOR SHALL ACCOMPLISH ALL NECESSARY COORDINATION WITH OTHER RELATED CONSTRUCTION PHASES AND CONTRACTORS FOR THIS PROJECT, INCLUDING AMTRAK FORCE ACCOUNT PERSONNEL.
- BEFORE ANY WORK IS COMMENCED, THE CONTRACTOR IS TO COORDINATE WITH AMTRAK REGARDING REQUIREMENTS OF TRACK AND/OR POWER OUTAGES FOLLOWING ALL STANDARD PROCEDURES AND SAFETY RULES.
- WORK SEQUENCES SHOWN IN GROUNDING AND BONDING STAGING PLANS IS SIMILAR FOR BOTH BRIDGES BEING REPLACED.
- 6. ALL CONTRACTOR PERSONNEL ARE REQUIRED TO PARTICIPATE IN THE RAILROAD'S SAFETY CONTRACTOR/LEASEE EMPLOYEE TRAINING CLASS PRIOR TO ENTERING AMTRAK PROPERTY.
- WORK WILL REQUIRE USE OF ON-TRACK HIGH RAIL BUCKET TRUCKS AND EQUIPMENT FOR THE INSTALLATION AND CONNECTION OF NEW BONDING WIRES AND PLATES, AND FOR THE REMOVAL AND DISCONNECTION OF EXISTING BONDING WIRES AND PLATES.
- ALL CONTRACTOR ON-TRACK HIGH RAIL EQUIPMENT IS TO BE INSPECTED AND APPROVED BY AMTRAK AT THEIR MAINTENANCE-OF-WAY FACILITY LOCATED IN NEW HAVEN, CT. THESE INSPECTIONS ARE TO BE MADE PRIOR TO USE OF THIS EQUIPMENT ON AMTRAK PROPERTY.
- 9. FOR THE REMOVAL OF THE EXISTING SUPERSTRUCTURE, INSTALLATION OF THE NEW DECK UNITS, REMOVAL AND INSTALLATION OF TEMPORARY FORMS, AND THE INSTALLATION OF METAL BRIDGE RAIL (SOLID PANEL), THE CATENARY AND FEEDER WIRES FOR BOTH TRACKS 1 AND 2 SHALL BE DE-ENERGIZED.
- 10. THE TIMES AND DURATIONS OF ALLOWED DE-ENERGIZING OF THE CATENARY AND FEEDER WIRES FOR TRACKS 1 AND 2 ARE SHOWN IN OTHER SECTIONS OF THE PLANS AND SPECIFICATIONS.
- 11. THE CONTRACTOR'S ON-TRACK HIGH RAIL EQUIPMENT WILL ONLY BE ALLOWED TO OCCUPY TRACK 1 OR 2 DURING ANY SCHEDULED TRACK AND CATENARY/FEEDER OUTAGE.
- 12. THE LOCATION FOR SETTING THE CONTRACTOR'S ON-TRACK HIGH RAIL EQUIPMENT ON THE TRACKS IS AT THE GOVERNOR WINTHROP BOULEVARD ROAD CROSSING IN NEW LONDON, CT NEAR MP 123.0, APPROXIMATELY 2 MILES FROM THE WORK SITE.
- 13. TRAVEL TIME FROM THE ON-TRACK HIGH RAIL ACCESS LOCATION TO THE WORK SITE, AND FOR RETURNING FROM THE WORK SITE TO THE ACCESS LOCATION, IS TO BE PART OF THE WORK PLAN FOR ANY WORK REQUIRING THE USE OF ON-TRACK HIGH RAIL EQUIPMENT.
- 14. ONLY ONE TRACK (TRACK 1 OR 2) WILL BE ALLOWED TO BE OCCUPIED BY THE CONTRACTOR'S ON-TRACK HIGH RAIL EQUIPMENT AT A TIME. DURING THE REMOVAL OF THE EXISTING BRIDGE BEAMS AND INSTALLATION OF NEW DECK UNITS, THE WORK MAY REQUIRE REMOVAL/INSTALLATION OF BONDING WIRES AND PLATES OVER BOTH TRACKS. THE CONTRACTOR'S ON-TRACK HIGH RAIL EQUIPMENT IS TO BE CAPABLE OF REACHING THE WORK AREAS OVER BOTH TRACKS 1 AND 2 WHILE SETTING ON ONLY ONE OF THE TRACKS.
- 15. DURING THE INSTALLATION OF THE TEMPORARY AND THE NEW METAL BRIDGE RAIL (SOLID PANEL), THE PANEL POSTS ARE TO BE BONDED TO EACH OTHER AND TO THE NEW AND/OR EXISTING BRIDGE BONDING SYSTEM AT ALL TIMES. THIS BONDING IS REQUIRED TO BE IN PLACE AT THE END OF EACH WORK SHIFT.
- 16. DURING THE REMOVAL OF THE EXISTING BRIDGE BEAMS, THE REMAINING IN-PLACE EXISTING BEAMS ON THE BRIDGE ARE TO BE BONDED TO THE NEW AND/OR EXISTING BRIDGE BONDING SYSTEM AT ALL TIMES. THIS BONDING IS REQUIRED TO BE IN PLACE AT THE END OF EACH WORK SHIFT.
- 17. DURING THE INSTALLATION OF THE NEW BRIDGE DECK UNITS, THE NEW BEAMS ARE TO BE BONDED TO THE NEW AND/OR EXISTING BRIDGE BONDING SYSTEM AT ALL TIMES. THIS BONDING IS REQUIRED TO BE IN PLACE AT THE END OF EACH WORK SHIFT.
- 18. AFTER INSTALLATION OF ALL NEW BRIDGE DECK UNITS AND THE ALUMINUM GROUNDING AND BONDING PLATES, THE CONTRACTOR SHALL MAKE A FINAL VISUAL INSPECTION OF THE LOCATION OF THE PLATES. DUE TO ANY TRACK MAINTENANCE THAT MAY HAVE BEEN DONE UNDER THE BRIDGES BY AMTRAK SINCE THE PROJECT WAS DESIGNED, THE LOCATION OF THE ALUMINUM GROUNDING AND BONDING PLATES MAY HAVE TO BE ADJUSTED. IF REQUIRED, THE CONTRACTOR SHALL FINAL ADJUST THE ATTACHMENT LOCATIONS OF THE PLATES SO THAT THE CENTER OF THE PLATES ARE ALIGNED DIRECTLY OVER THE CATENARY WIRES. THIS WORK, IF REQUIRED, SHALL BE PAID AS INCIDENTAL TO THE INSTALLATION OF THE GROUNDING AND BONDING SYSTEM.

THE INFORMATION, INCLUDING ESTIMATED QUANTITIES OF WORK, SHOWN ON THESE SHEETS IS BASED ON LIMITED INVESTIGATIONS BY THE STATE AND IS NO WAY WARRANTED TO INDICATE THE CONDITIONS OF ACTUAL QUANTITIES OF WORK WHICH WILL BE REQUIRED. SHEET NO. Plotted Date: 3/3/2016 REVISION DESCRIPTION REV. DATE

AJM WJS/WWF

SCALE AS NOTED



Filename: ...\058_332_G&B_gen_notes_legend_Sheet.dgn

GANNETT FLEMING

RECONSTRUCTION OF ROUTE 349 NB AND SB OVER AMTRAK RAILROAD **GROTON**

058-332 GROUNDING & BONDING BBG-01 GENERAL NOTES, LEGEND, SHEET NO. AND ABBREVIATIONS

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ABBREVIATIONS:

- ALUMINUM

AWG - AMERICAN WIRE GAUGE - CENTER LINE

- DIAMETER - DRAWING DWG - EACH

- RAILROAD FEEDER - MAXIMUM

- EXISTING

- MINIMUM MIN

EX.

- NATIONAL ELECTRICAL MANUFACTURERS ASSOCIATION

ACSR - ALUMINUM CONDUCTOR STEEL REINFORCED

NOM. - NOMINAL - NUMBER NO. N.T.S. - NOT TO SCALE

- ON CENTER

- OVERHEAD CATENARY SYSTEM OCS

- STAINLESS STEEL - RAILROAD STATIC WIRE


- TOP OF RAIL

TPCBC - TEMPORARY PRECAST CONCRETE BARRIER CURB


TYP - TYPICAL - WITH

DETAIL CALLOUT


— DETAIL NUMBER BBG-07 DRAWING NUMBER WHERE DETAIL IS DRAWN

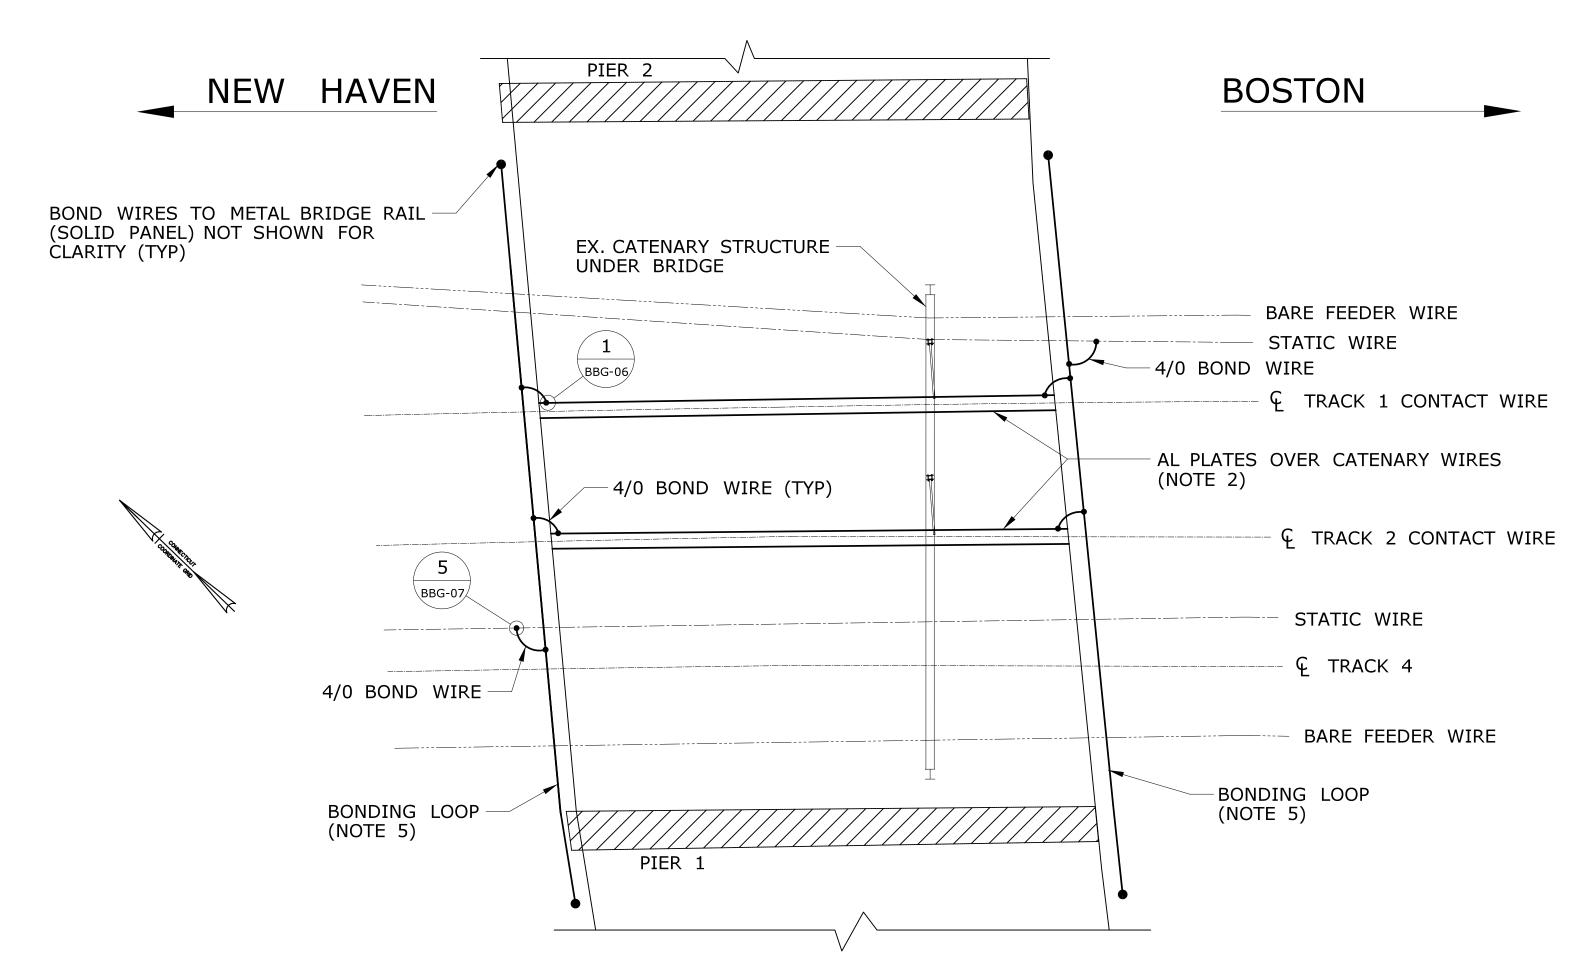

PROPOSED BRIDGE NO. 03330 PLAN VIEW SCALE: N.T.S.

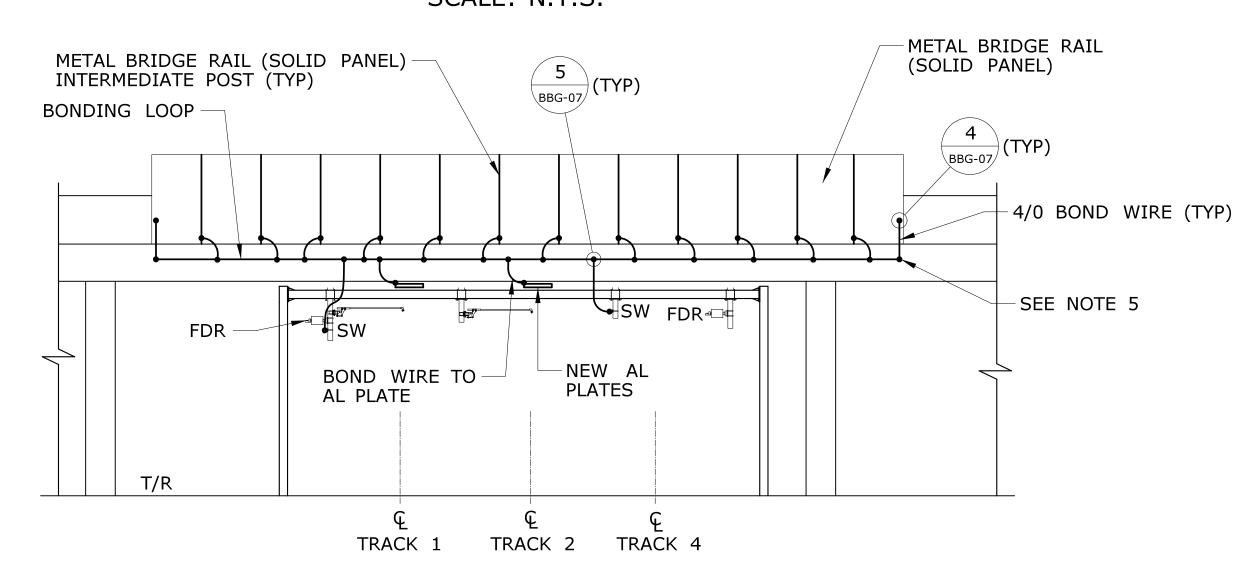

PROPOSED BRIDGE NO. 03330 ELEVATION VIEW LOOKING TOWARDS BOSTON SCALE: N.T.S.

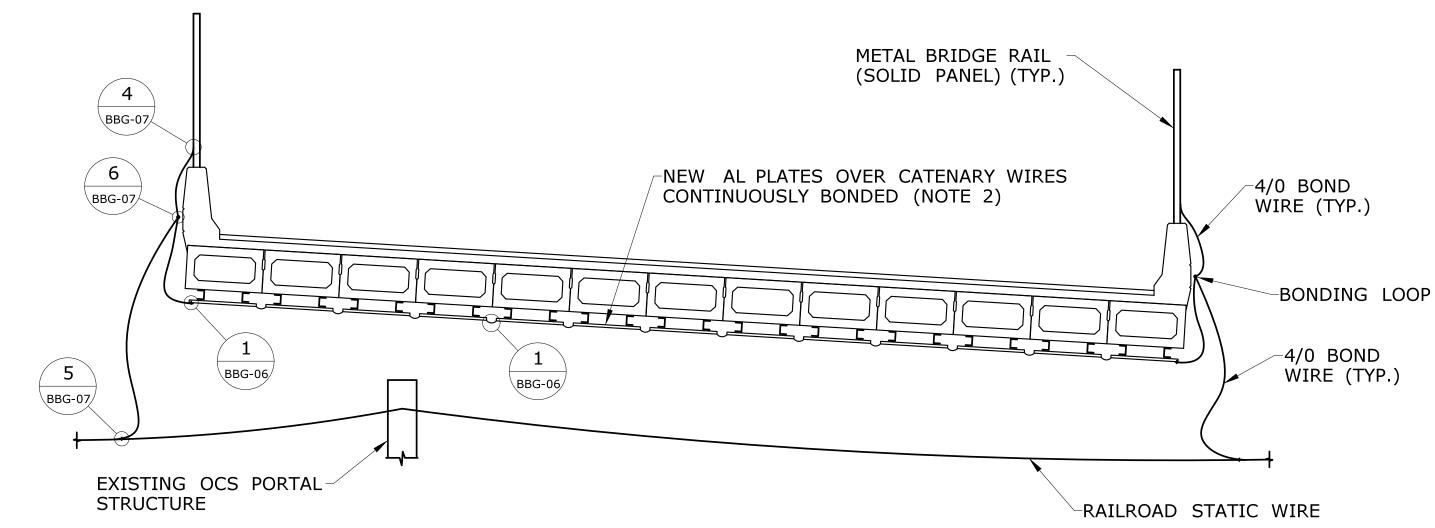


PROPOSED BRIDGE NO. 03330 SECTION VIEW SCALE: N.T.S.

NOTES:


- 1. SOUTHBOUND BRIDGE SHOWN, APPROXIMATE RAILROAD STATION 124+5006.
- 2. SEE DWG NO. BBG-06 FOR ADDITIONAL DETAILS FOR THE ALUMINUM PLATES.
- 3. ALL BOND WIRE JUMPERS AND BONDING LOOPS ARE TO BE 4/0 ALUMINUM UNLESS OTHERWISE NOTED.
- 4. SEE THE STRUCTURAL SUBSET OF THIS PROJECT FOR ADDITIONAL DETAILS OF BRIDGE SUBSTRUCTURE, BRIDGE SUPERSTRUCTURE, METAL BRIDGE RAIL (SOLID PANEL), ETC.
- 5. THE BONDING LOOP IS TO BE ATTACHED TO THE BRIDGE PARAPET EVERY 3'-0" (NOM.) O.C. SEE DETAIL 6 ON DWG NO. BBG-07 FOR TYPICAL ATTACHMENT DETAIL.

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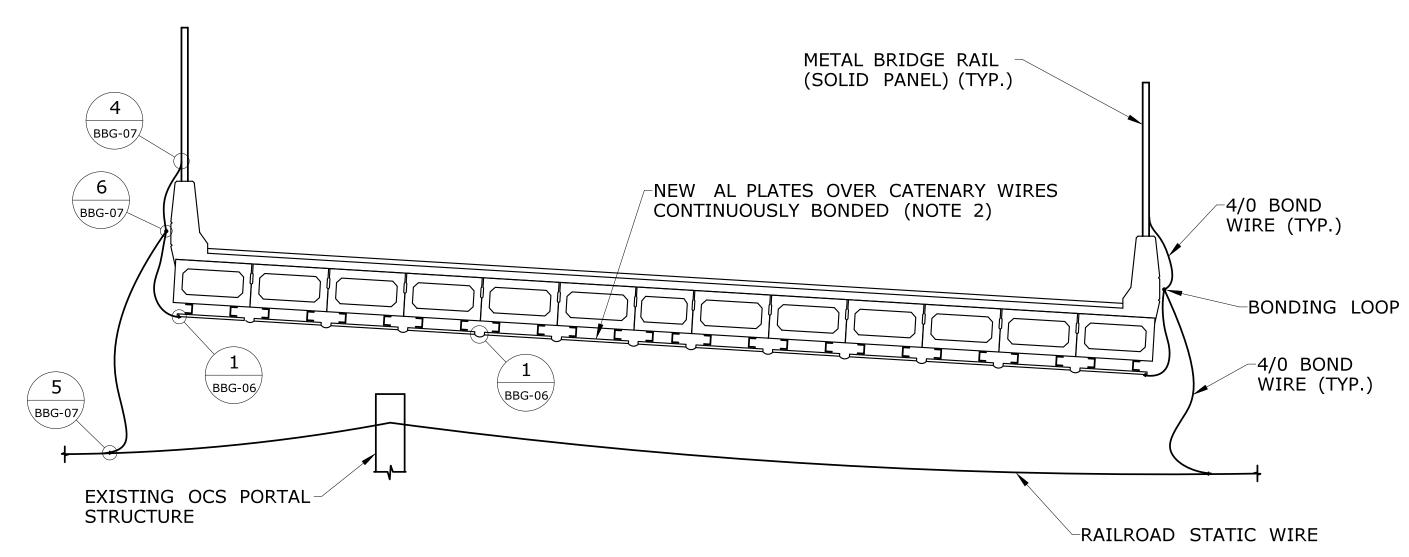
STATE OF CONNECTICUT 058-332 MLA **GROTON** THE INFORMATION, INCLUDING ESTIMATED QUANTITIES OF WORK, SHOWN ON THESE SHEETS IS BASED ON LIMITED INVESTIGATIONS BY THE STATE AND IS IN NO WAY WARRANTED TO INDICATE THE CONDITIONS OF ACTUAL QUANTITIES OF WORK WHICH WILL BE REQUIRED. RECONSTRUCTION OF ROUTE 349 NB AND SB OVER AMTRAK RAILROAD **GANNETT FLEMING** WJS/WWF GROUNDING & BONDING BBG-02 **DEPARTMENT OF TRANSPORTATION** ROUTE 349 SOUTHBOUND SHEET NO. BRIDGE NO. 03330 SCALE AS NOTED Filename: ...\058_332_G&B_SB_pro_pln_ele_Sheet.dgn REVISION DESCRIPTION REV. DATE SHEET NO. Plotted Date: 3/2/2016

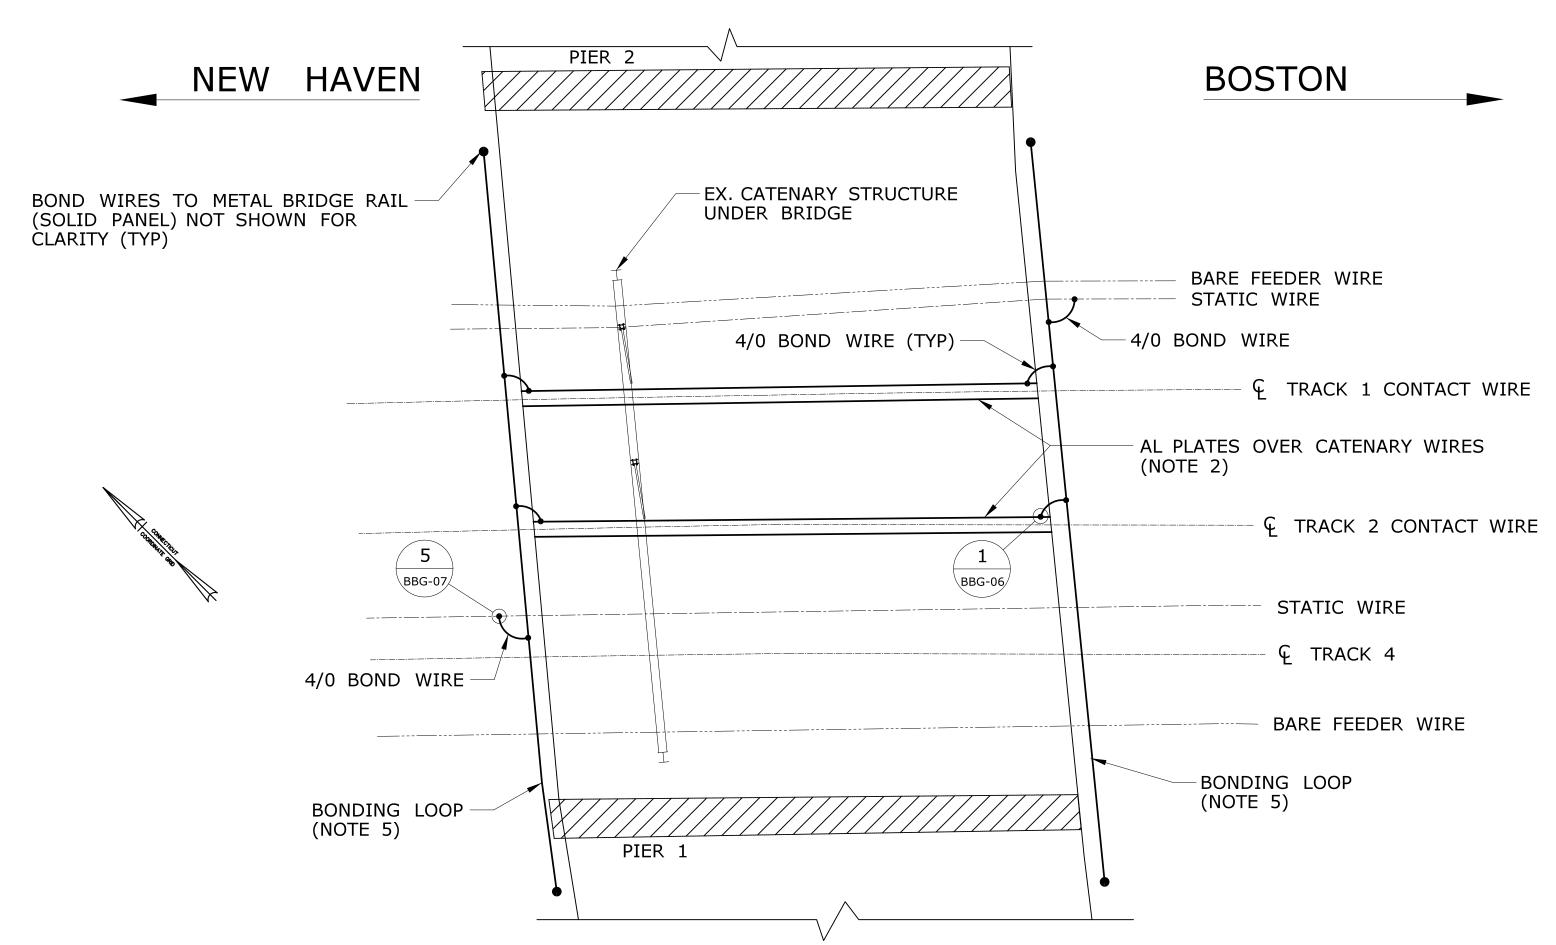

PROPOSED BRIDGE NO. 03331 PLAN VIEW SCALE: N.T.S.

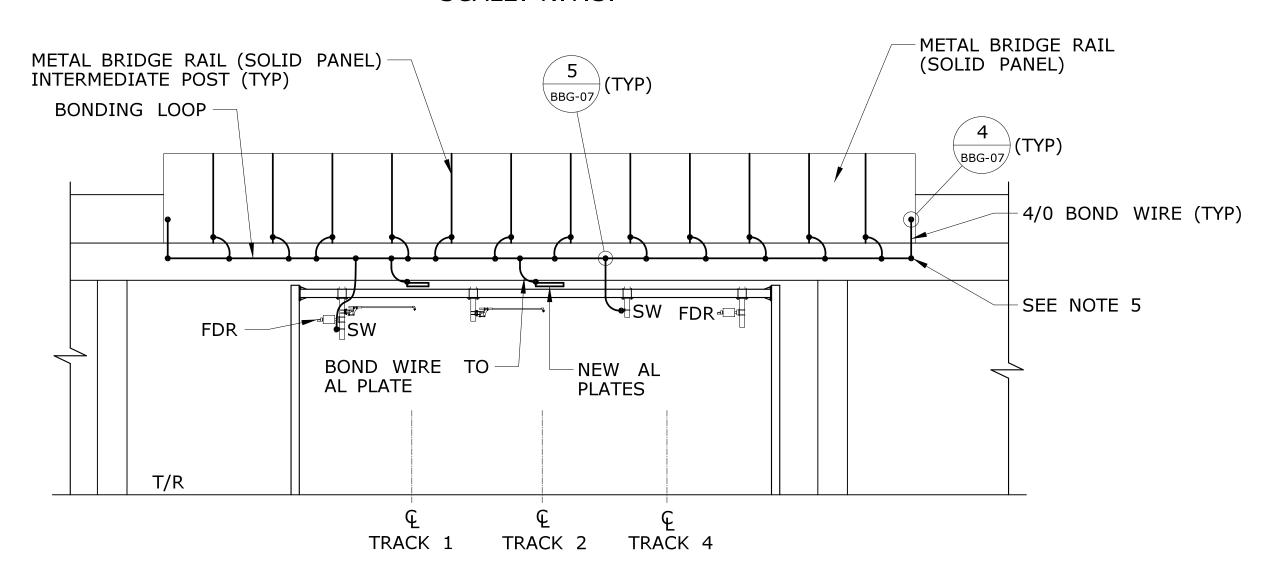

PROPOSED BRIDGE NO. 03331 ELEVATION VIEW LOOKING TOWARDS BOSTON SCALE: N.T.S.



PROPOSED BRIDGE NO. 03331 SECTION VIEW SCALE: N.T.S.


NOTES:

- 1. NORTHBOUND BRIDGE SHOWN, APPROXIMATE RAILROAD STATION 124+5064.
- 2. SEE DWG NO. BBG-06 FOR ADDITIONAL DETAILS FOR THE ALUMINUM PLATES.
- 3. ALL BOND WIRE JUMPERS AND BONDING LOOPS ARE TO BE 4/0 ALUMINUM UNLESS OTHERWISE NOTED.
- 4. SEE THE STRUCTURAL SUBSET OF THIS PROJECT FOR ADDITIONAL DETAILS OF BRIDGE SUBSTRUCTURE, BRIDGE SUPERSTRUCTURE, METAL BRIDGE RAIL (SOLID PANEL), ETC.
- 5. THE BONDING LOOP IS TO BE ATTACHED TO THE BRIDGE PARAPET EVERY 3'-0" (NOM.) O.C. SEE DETAIL 6 ON DWG NO. BBG-07 FOR TYPICAL ATTACHMENT DETAIL.

	THE INFORMATION, INCLUDING ESTIMATED OUANTITIES OF WORK, SHOWN ON THESE	DESIGNER/DRAFTER: AJM CHECKED BY:	CONNECTICO:	SIGNATURE/ BLOCK:	RECONSTRUCTION OF	GROTON	PROJECT NO. 058-332
	SHEETS IS BASED ON LIMITED INVESTIGATIONS BY THE STATE AND IS IN NO WAY WARRANTED TO INDICATE THE COMMUNICAL WILL BE DECLIDED.	WJS/WWF	DEPARTMENT OF TRANSPORTATION	GANNETT FLEMING APPROVED BY:	RECONSTRUCTION OF ROUTE 349 NB AND SB OVER AMTRAK RAILROAD	GROUNDING & BONDIN	
REV. DATE	REVISION DESCRIPTION SHEET NO. Plotted Date: 3/2/2016	SCALE AS NOTED	Filename:\058_332_G&B_NB_pro_pln_ele_Sheet.dgn	- -	OVER AMIRAK KAILKOAD	ROUTE 349 NORTHBOUN BRIDGE NO. 03331	D SHEET NO.


STAGE 1

- 1. THE WEST SIDE OF THE ROADWAY TAKEN OUT OF SERVICE.
- 2. INSTALL TEMPORARY PRECAST CONCRETE BARRIER CURBS WITH TEMPORARY PROTECTIVE FENCE PANELS.
- 3. BOND THE TEMPORARY PROTECTIVE FENCE PANEL POSTS TO EACH OTHER, AND TO THE EXISTING BRIDGE BONDING SYSTEM THAT IS ATTACHED TO THE BOTTOM OF THE EXISTING BEAMS.

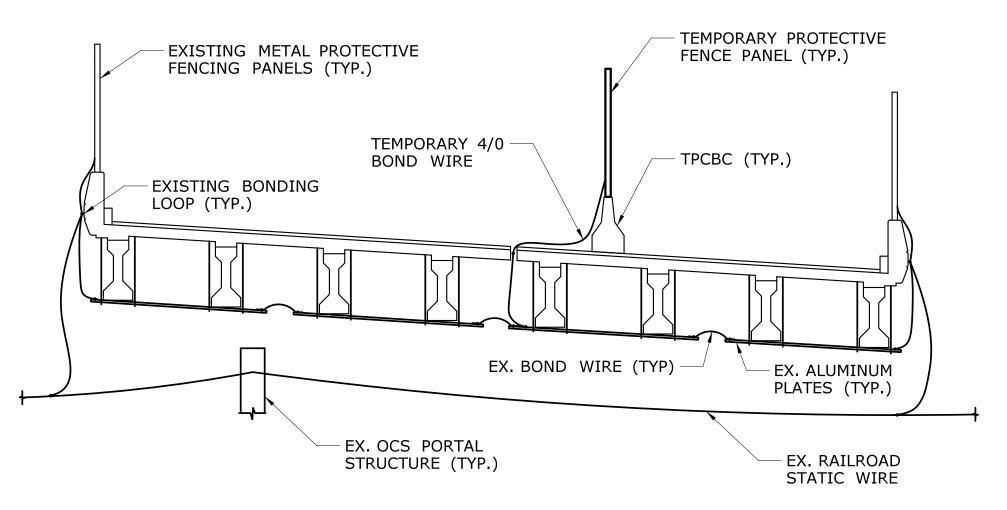

STAGE 2

- 1. REMOVE FIRST TWO EXISTING BEAMS, ONE AT A TIME.
- 2. DISCONNECT EXISTING ALUMINUM PLATE BOND WIRES BETWEEN BEAMS BEING REMOVED AND THE EXISTING BRIDGE BONDING SYSTEM.

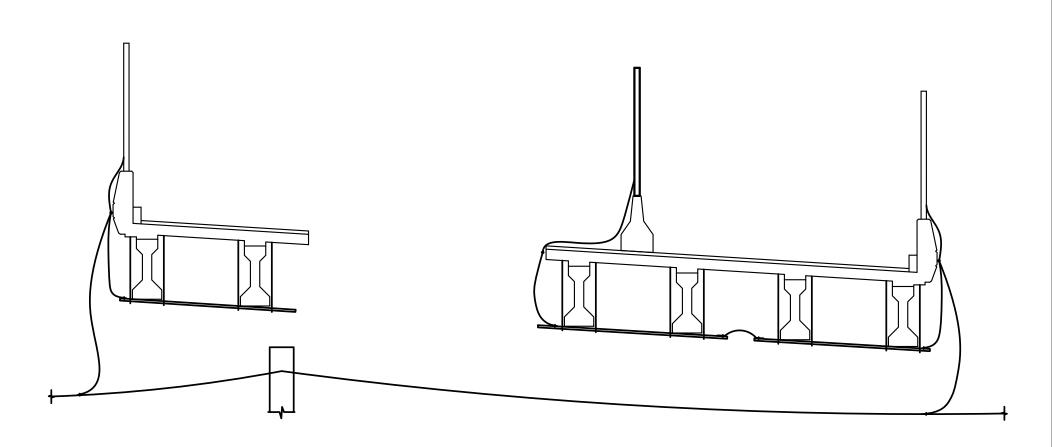


STAGE 3

REV. DATE

- 1. REMOVE EXISTING METAL PROTECTIVE FENCING PANELS FROM TOP OF PARAPET. REMOVE EXISTING BONDING WIRES FROM METAL PROTECTIVE FENCING PANELS.
- 2. REMOVE EXISTING CONCRETE PARAPET.
- 3. REMOVE SECOND TWO EXISTING BEAMS, ONE AT A TIME.


REVISION DESCRIPTION

4. DISCONNECT EXISTING BOND WIRES BETWEEN BEAMS BEING REMOVED, AND THE EXISTING RAILROAD STATIC WIRE.

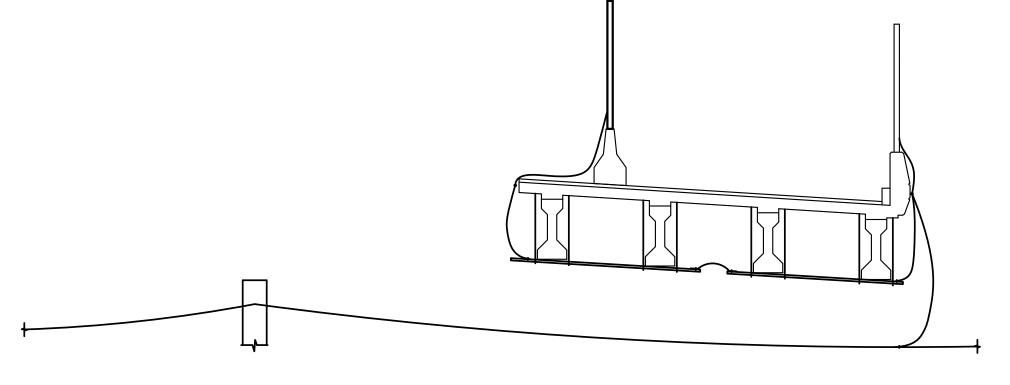


STAGE 4

- 1. INSTALL THE FIRST TWO NEW DECK UNITS, ONE AT A TIME.
- 2. CONNECT THE NEW ALUMINUM PLATES AND FLEXIBLE BOND WIRE JUMPERS TO EACH OTHER, AND TO THE EXISTING BRIDGE BONDING SYSTEM.

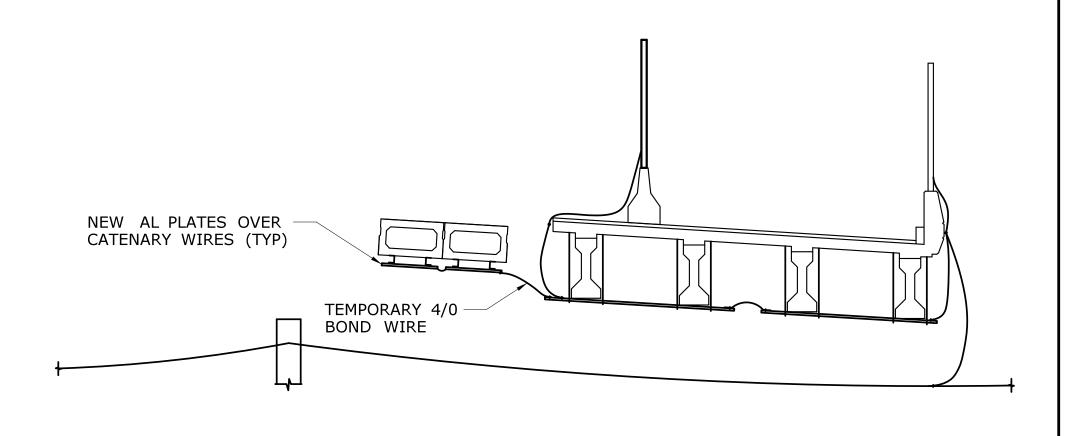


STAGE 5

- 1. INSTALL THE SECOND SET OF TWO NEW DECK UNITS, ONE AT A TIME.
- 2. CONNECT THE NEW ALUMINUM PLATES AND FLEXIBLE BOND WIRE JUMPERS TO EACH OTHER, AND TO THE NEW BRIDGE BONDING SYSTEM.

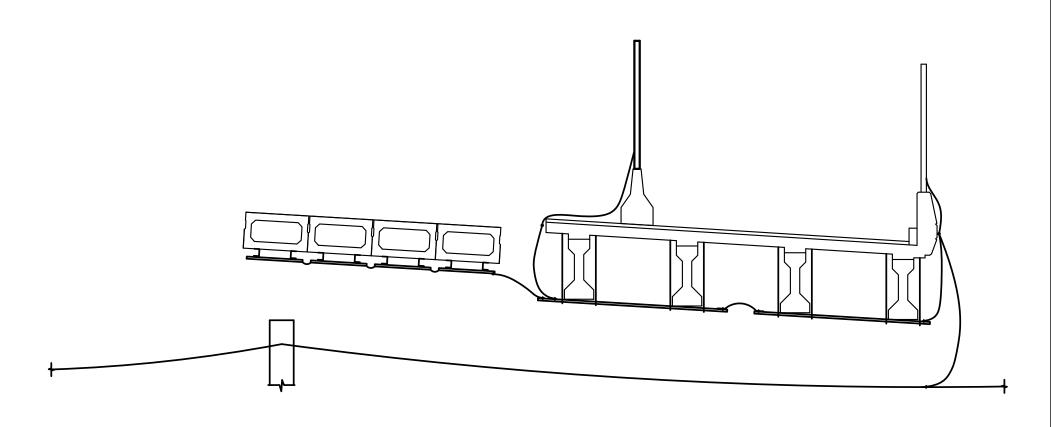

STAGE 6

- INSTALL THE THIRD SET OF TWO NEW DECK UNITS, ONE AT A TIME.
- 2. CONNECT THE NEW ALUMINUM PLATES AND FLEXIBLE BOND WIRE JUMPERS TO EACH OTHER, AND TO THE NEW BRIDGE BONDING SYSTEM.
- 3. INSTALL NEW CONCRETE FASCIA PARAPET.
- 4. INSTALL NEW METAL BRIDGE RAIL (SOLID PANEL) ABOVE THE PARAPET. BOND THE NEW METAL BRIDGE RAIL (SOLID PANEL) POSTS TO EACH OTHER, AND TO THE NEW BRIDGE BONDING SYSTEM.
- 5. INSTALL NEW BOND WIRE BETWEEN THE EXISTING RAILROAD STATIC WIRE AND THE NEW BRIDGE BONDING SYSTEM.
- 6. INSTALL TEMPORARY PRECAST CONCRETE BARRIER CURBS WITH TEMPORARY PROTECTIVE FENCE PANELS.
- 7. BOND THE TEMPORARY PROTECTIVE FENCE PANEL POSTS TO EACH OTHER, AND TO THE NEW BRIDGE BONDING SYSTEM.

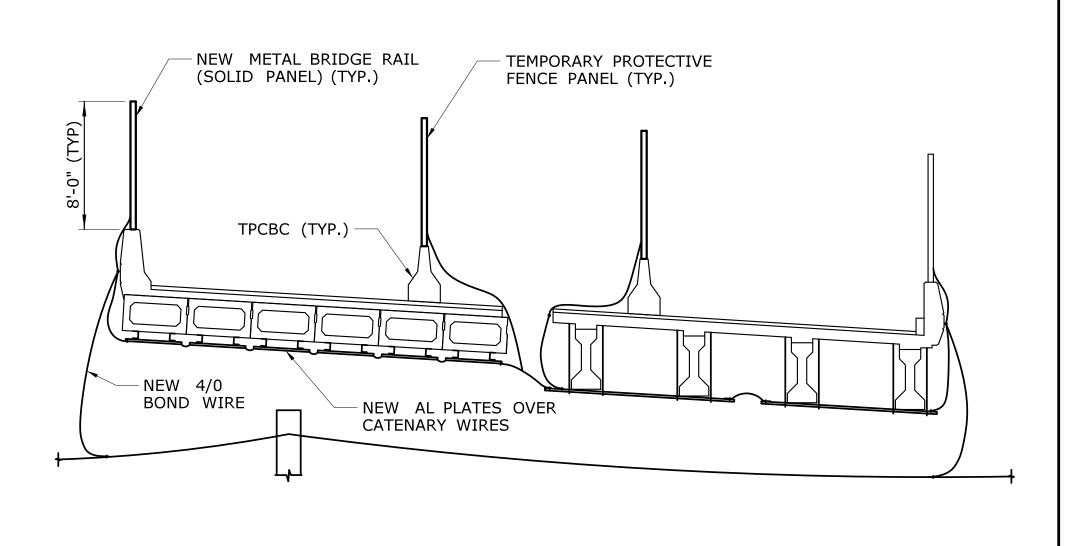

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SHEET NO. Plotted Date: 3/3/2016

AJM
CHECKED BY:
WJS/WWF

SCALE AS NOTED

STATE OF CONNECTICUT DEPARTMENT OF TRANSPORTATION

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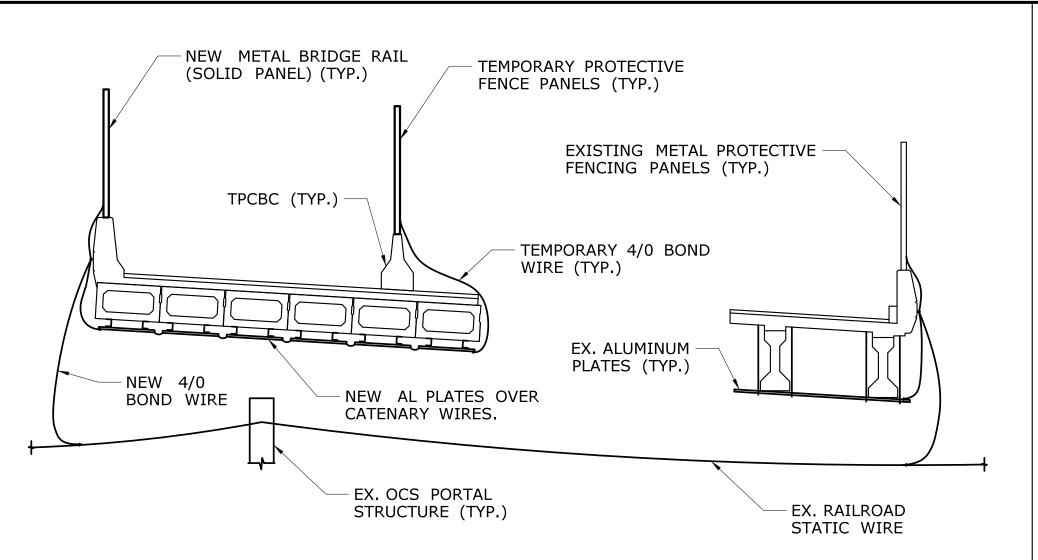
BLOCK:
GANNETT FLEMING
APPROVED BY:

RECONSTRUCTION OF ROUTE 349 NB AND SB OVER AMTRAK RAILROAD

GROTON	PROJECT NO. 058-33
GROUNDING & BONDING	BBG-0
STAGING PLANS SHEET 1 OF 2	SHEET NO.


STAGE 7

- 1. THE WEST SIDE OF THE ROADWAY IS PUT INTO SERVICE.
- 2. THE EAST SIDE OF THE ROADWAY IS TAKEN OUT OF SERVICE
- 3. DISCONNECT THE BOND WIRE BETWEEN THE NEW AND EXISTING BRIDGE BONDING SYSTEMS.
- 4. REMOVE THE TEMPORARY PROTECTIVE FENCE PANELS ON THE EAST SIDE OF THE ROADWAY. REMOVE BONDING WIRES FROM THE TEMPORARY PROTECTIVE FENCE PANELS.
- 5. REMOVE THE TEMPORARY PRECAST CONCRETE BARRIER CURBS.
- 6. REMOVE TWO EXISTING BEAMS, ONE AT A TIME.
- 7. DISCONNECT EXISTING ALUMINUM PLATE BOND WIRES BETWEEN BEAMS BEING REMOVED AND THE EXISTING BRIDGE BONDING SYSTEM.



STAGE 8


- 1. REMOVE EXISTING METAL PROTECTIVE FENCING PANELS FROM TOP OF PARAPET. REMOVE EXISTING BONDING WIRES FROM METAL PROTECTIVE FENCING PANEL POSTS.
- 2. REMOVE EXISTING CONCRETE PARAPET.
- 3. REMOVE THE LAST TWO EXISTING BEAMS, ONE AT A TIME.
- 4. DISCONNECT EXISTING BOND WIRES BETWEEN BEAMS BEING REMOVED AND THE EXISTING RAILROAD STATIC WIRE.

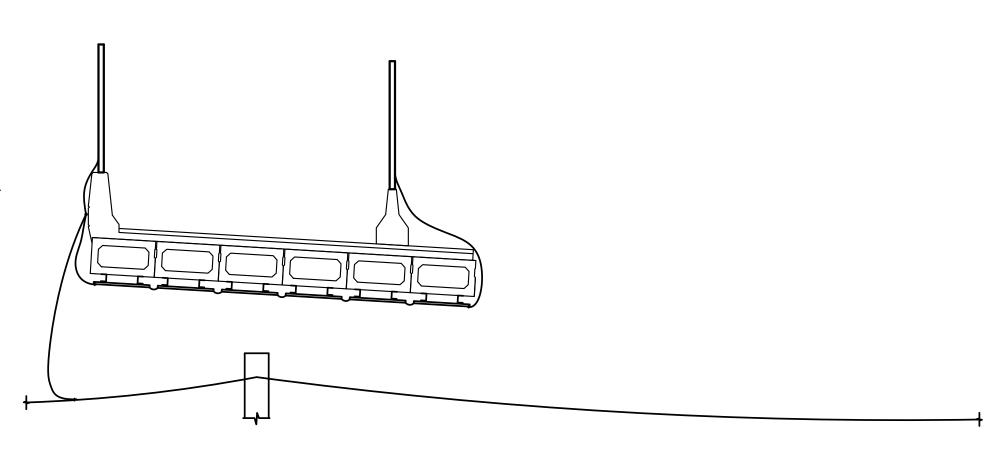

STAGE 9


REV. DATE

- 1. INSTALL TWO NEW DECK UNITS, ONE AT A TIME.
- 2. CONNECT THE NEW ALUMINUM PLATES AND FLEXIBLE BOND WIRE JUMPERS TO EACH OTHER, AND TO THE NEW BRIDGE BONDING SYSTEM.

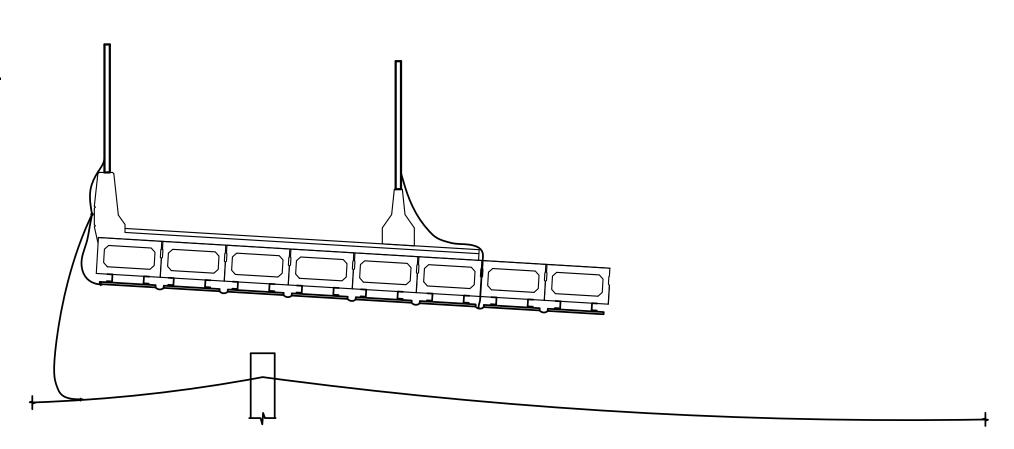


STAGE 10

- 1. INSTALL TWO NEW DECK UNITS, ONE AT A TIME.
- 2. CONNECT THE NEW ALUMINUM PLATES AND FLEXIBLE BOND WIRE JUMPERS TO EACH OTHER, AND TO THE NEW BRIDGE BONDING SYSTEM.

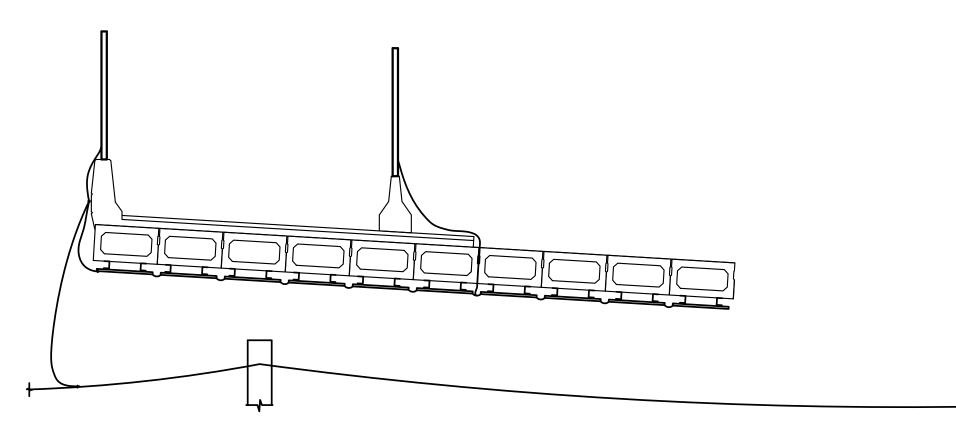


STAGE 11

- 1. INSTALL THE LAST THREE NEW DECK UNITS, ONE AT A TIME.
- 2. CONNECT THE NEW ALUMINUM PLATES AND FLEXIBLE BOND WIRE JUMPERS TO EACH OTHER, AND TO THE NEW BRIDGE BONDING SYSTEM.
- 3. INSTALL NEW CONCRETE FASCIA PARAPET.
- 4. INSTALL NEW METAL BRIDGE RAIL (SOLID PANEL) ABOVE THE PARAPET. BOND THE NEW METAL BRIDGE RAIL (SOLID PANEL) POSTS TO EACH OTHER, AND TO THE NEW BRIDGE BONDING SYSTEM.
- 5. INSTALL NEW BOND WIRE BETWEEN THE EXISTING RAILROAD STATIC WIRE AND THE NEW BRIDGE BONDING SYSTEM.

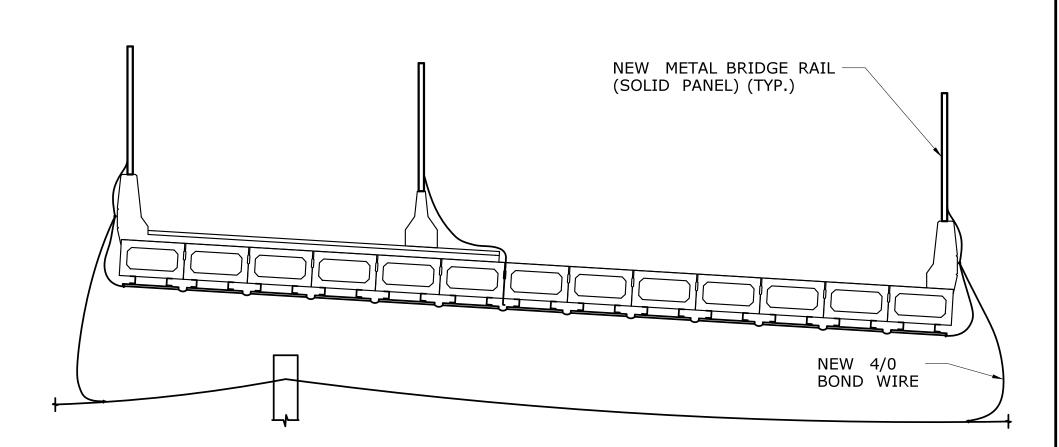

STAGE 12

- 1. REMOVE THE REMAINING TEMPORARY PROTECTIVE FENCE PANELS. REMOVE BONDING WIRES FROM THE TEMPORARY PROTECTIVE FENCE PANEL POSTS.
- 2. REMOVE THE REMAINING TEMPORARY PRECAST CONCRETE BARRIER CURBS.

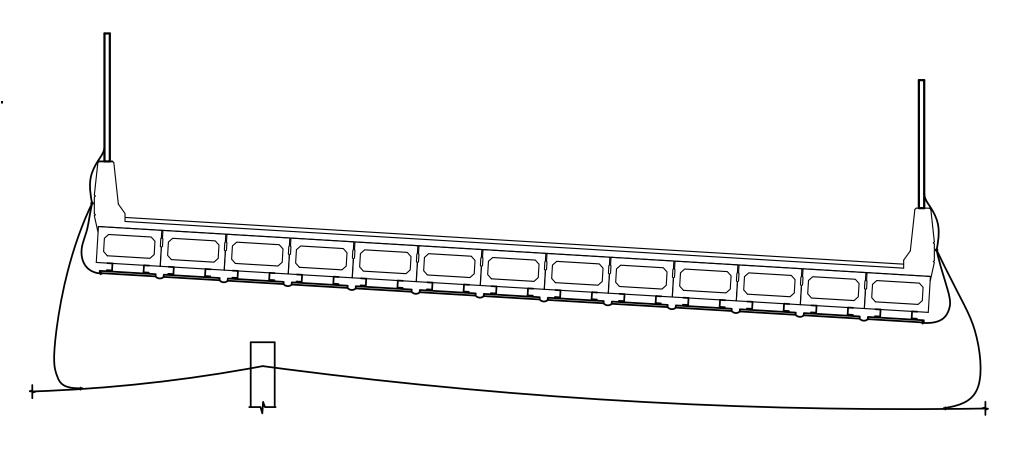


90% SUBMISSION 03/09/2016

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SHEET NO. Plotted Date: 3/3/2016

REVISION DESCRIPTION


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WJS/WWF	TRANSTULT
	DEP
SCALE AS NOTED	

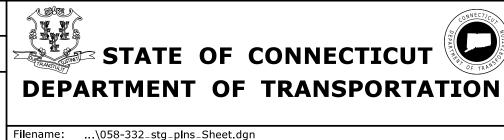

SIGNATURE/ BLOCK:	PROJECT	TITLE:
GANNETT FLEMING		
APPROVED BY:		C
	I	

RECONSTRUCTION OF ROUTE 349 NB AND SB OVER AMTRAK RAILROAD


GROTON	PROJECT NO. 058-3 ;
GROUNDING & BONDING	BBG-0
STAGING PLANS SHEET 2 OF 2	SHEET NO.

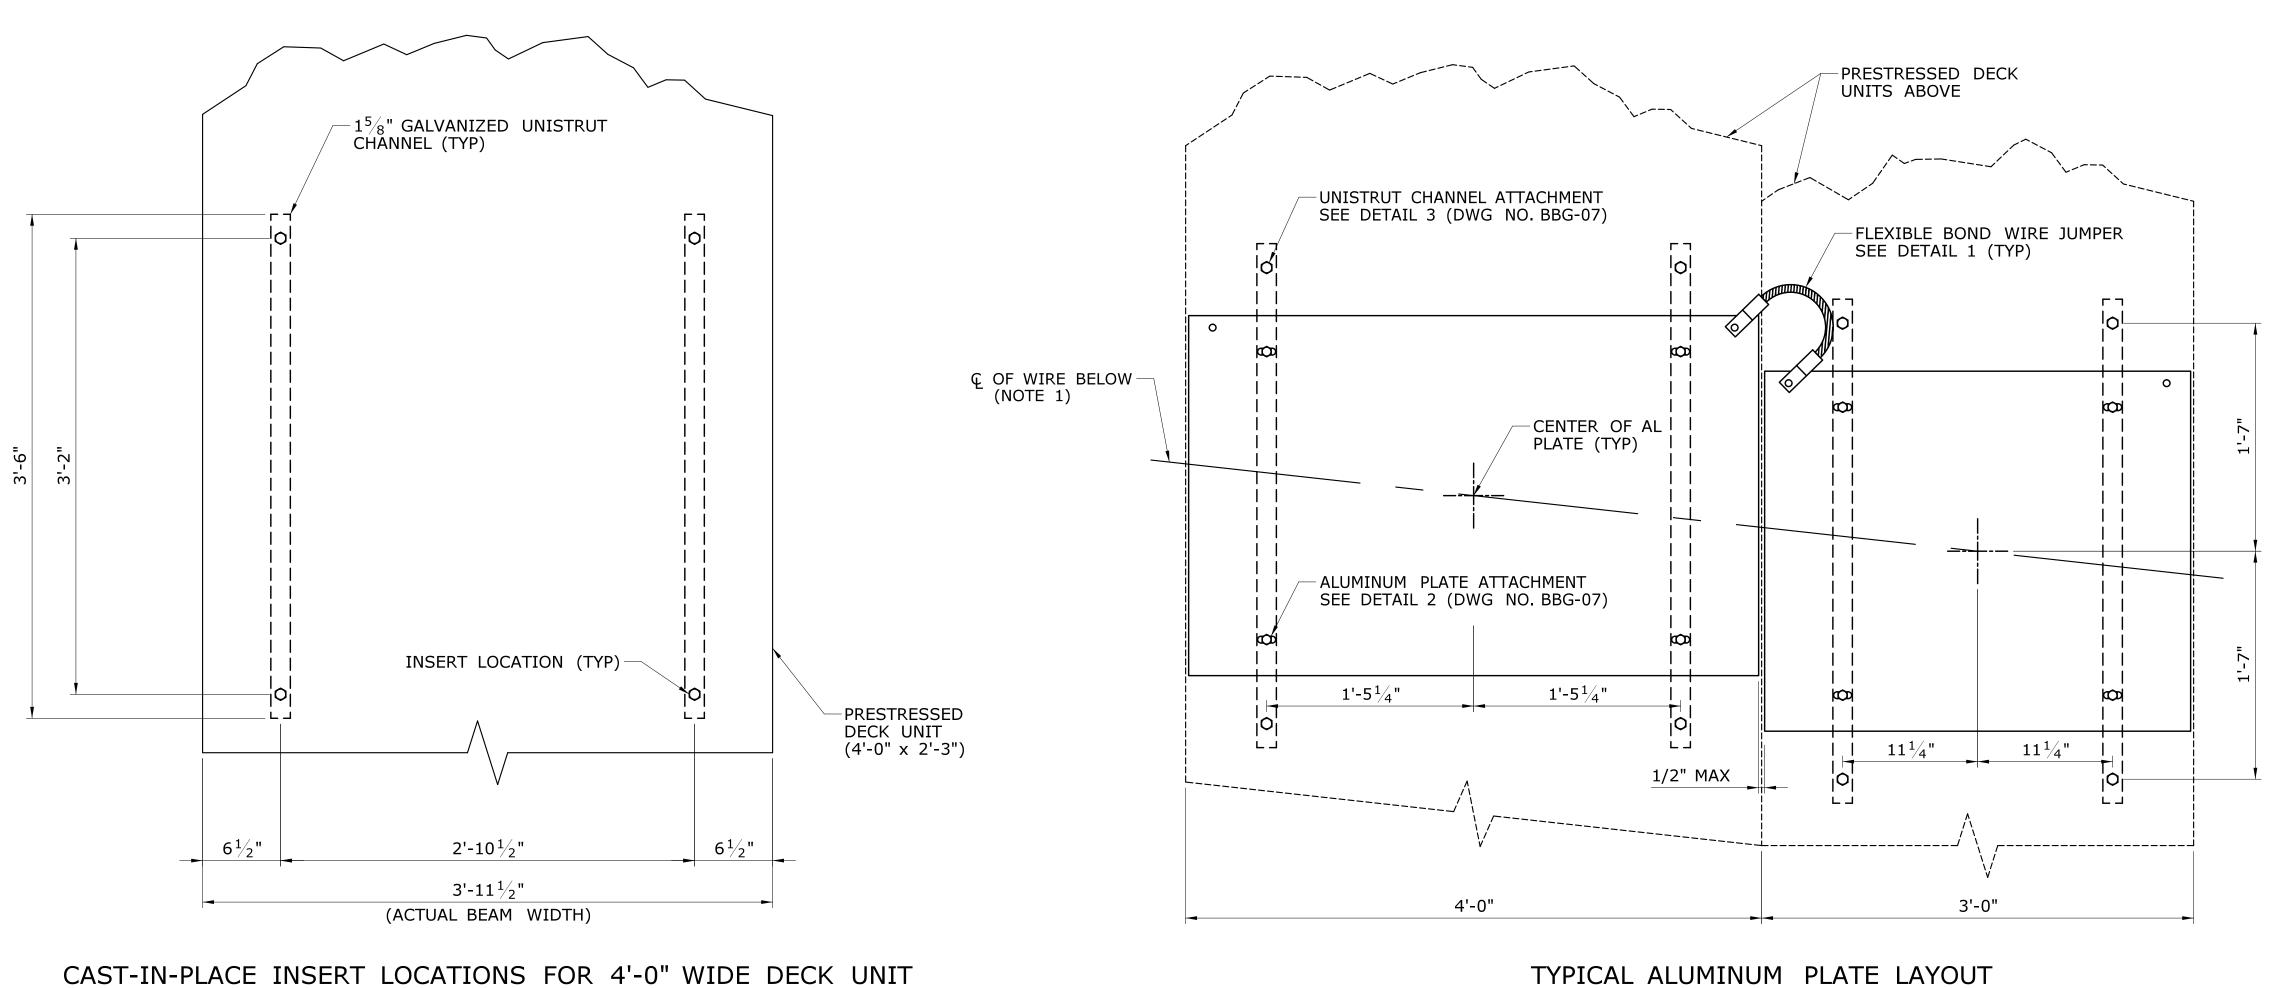


NOTES:

- 1. CONTRACTOR SHALL SURVEY EXISTING WIRES TO CONFIRM THEIR ASSUMED LOCATIONS PRIOR TO SETTING INSERT LOCATIONS.
- 2. SEE FRAMING PLANS IN STRUCTURAL SUBSET FOR ASSUMED WIRE LOCATIONS.
- 3. CONFIRM INSERT LOCATIONS IN DECK UNITS PRIOR TO FABRICATION OF ALUMINUM PLATES.
- 4. THE TOTAL LENGTH OF THE FLEXIBLE BOND WIRE JUMPERS SHALL BE 1'-6" (FROM END OF LUG TO END OF LUG) AND SHALL HAVE A MINIMUM BENDING RAIDUS OF 3".


TYPICAL ALUMINUM PLATE LAYOUT SCALE: N.T.S.

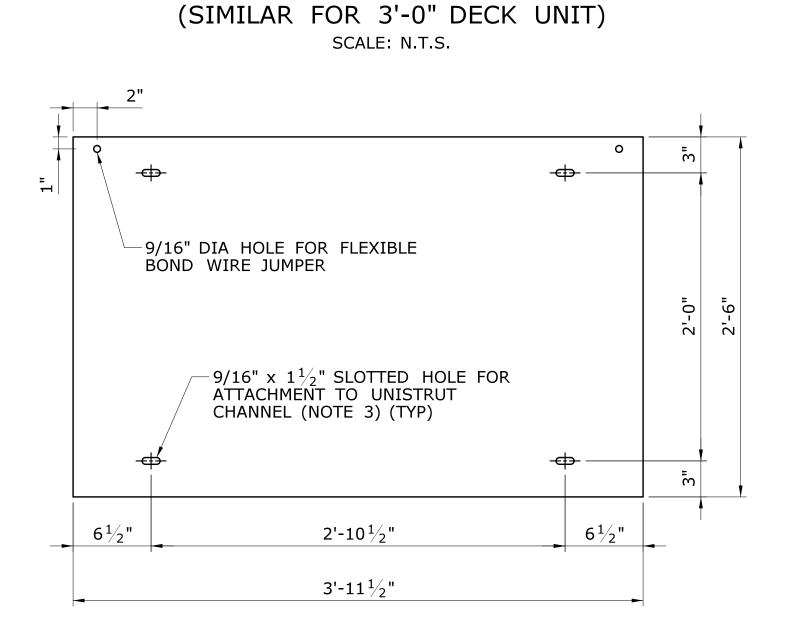

ALUMINUM PLATE FOR 4'-0" WIDE DECK UNIT SCALE: N.T.S.

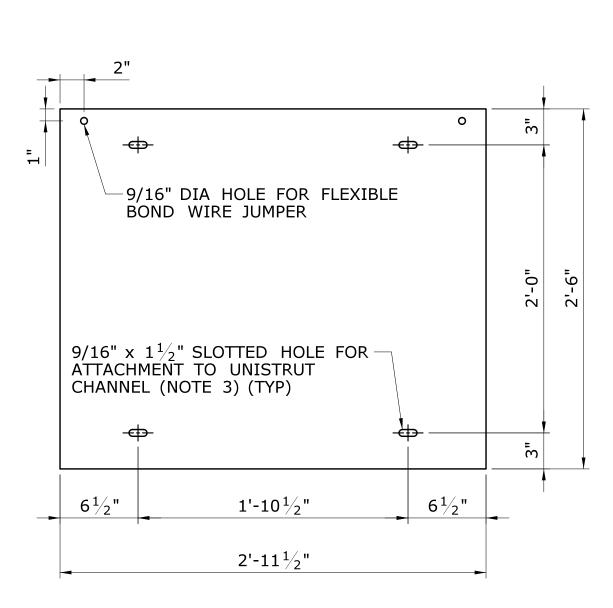


ALUMINUM PLATE FOR 3'-0" WIDE DECK UNIT SCALE: N.T.S.

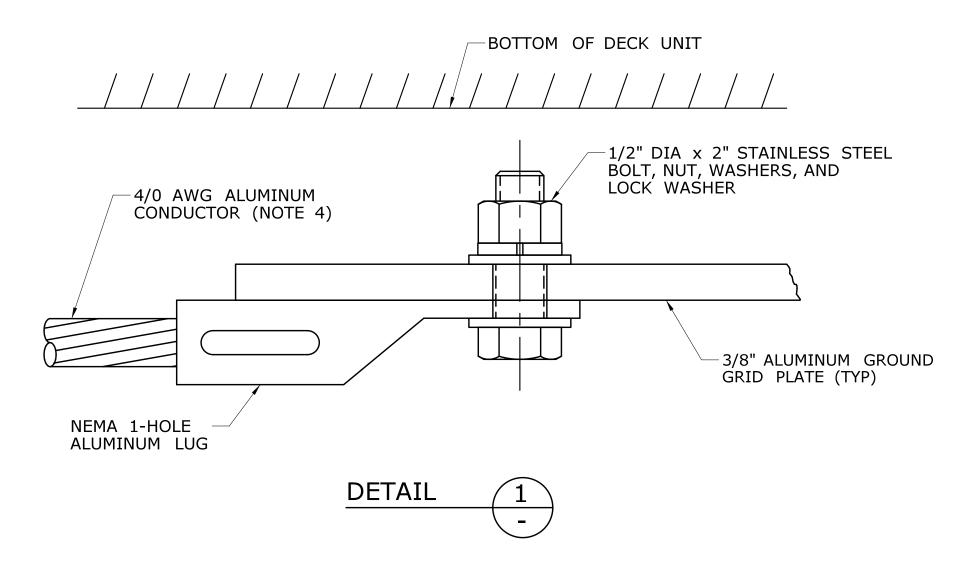


CONNECTION OF FLEXIBLE BOND WIRE JUMPER TO ALUMINUM PLATES SCALE: N.T.S.

90%	SUBMISSION	03/09/2016


THE INFORMATION, INCLUDING ESTIMATED QUANTITIES OF WORK, SHOWN ON THESE	ESIGNER/DRAFTER: AJM THECKED BY:	CONNECTION IS	SIGNATURE/ BLOCK:	PROJECT TITLE: RECONSTRUCTION OF	GROTON	PROJECT NO. 058-332
SHEETS IS BASED ON LIMITED INVESTIGATIONS BY THE STATE AND IS IN NO WAY WARRANTED TO INDICATE THE CONDITIONS OF ACTUAL QUANTITIES	WJS/WWF	DEPARTMENT OF TRANSPORTATION	GANNETT FLEMING APPROVED BY:	ROUTE 349 NB AND SB	GROUNDING & BONDING	BBG-06
OF WORK WHICH WILL BE REQUIRED. REV. DATE REVISION DESCRIPTION SHEET NO Plotted Date: 3/3/2016	SCALE AS NOTED	Filename: \058 332 G&B assembly details Sheet 1 dgn		OVER AMTRAK RAILROAD	ASSEMBLY DETAILS SHEET 1 OF 2	SHEET NO.

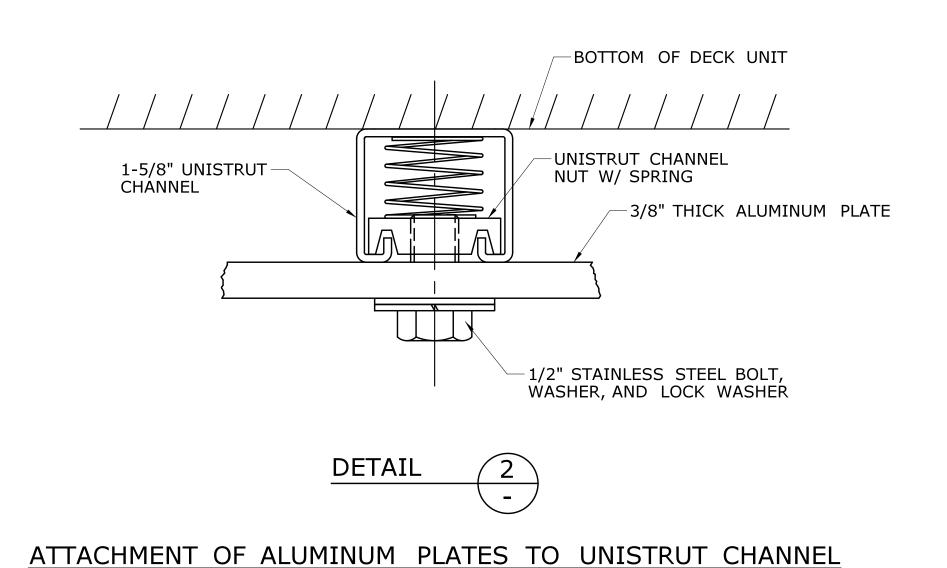



SCALE: N.T.S.

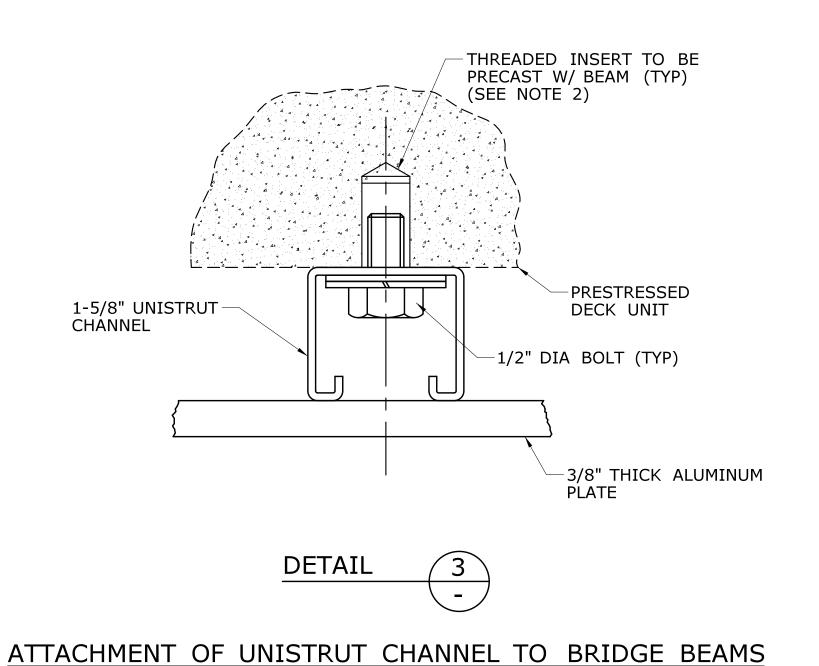

SCALE: N.T.S.

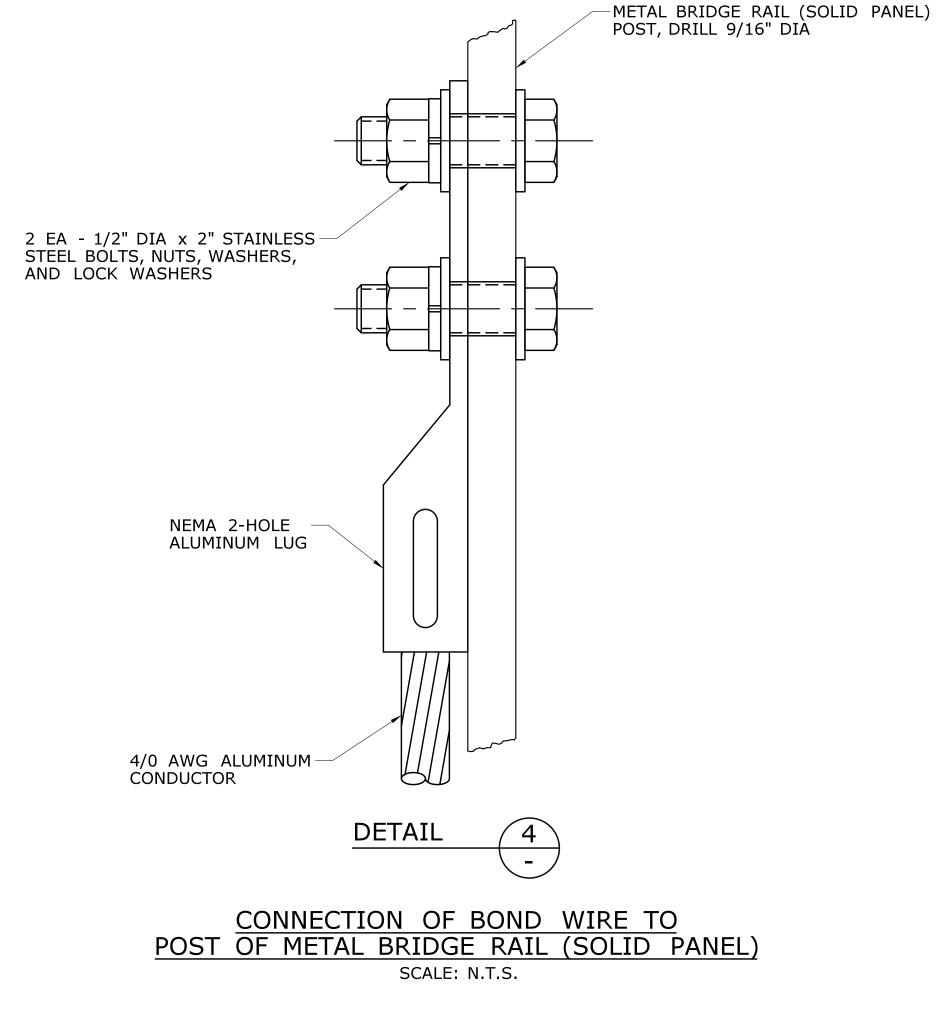

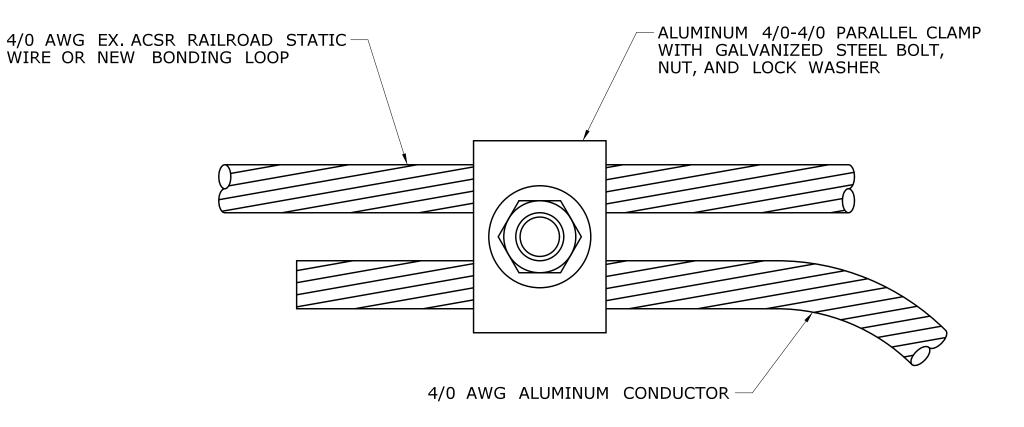

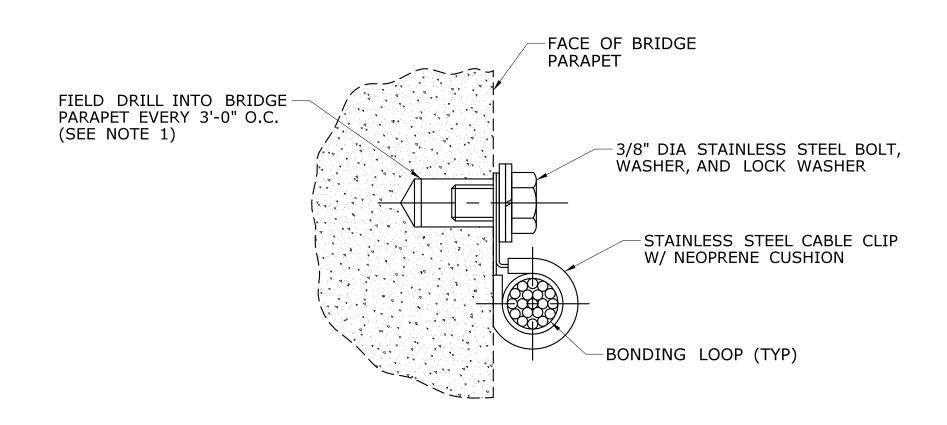

NOTES:

1. CONTRACTOR TO PROVIDE A MECHANICAL OR ADHESIVE ANCHORING SYSTEM WITH A MINIMUM NOMINAL EMBEDMENT DEPTH OF 2 $^5\!/_{16}$ ".

2. THE THREADED INSERTS PRECAST WITH THE DECK UNITS SHALL BE INCIDENTAL TO THE PRESTRESSED DECK UNITS. ALL OTHER WORK SHOWN ON THIS PLAN SHEET SHALL BE INCIDENTAL TO THE GROUNDING AND BONDING SYSTEM.

DETAIL 5

PARALLEL CLAMP FOR ATTACHMENT OF BOND WIRES

TO RAILROAD STATIC WIRE AND BONDING LOOP

SCALE: N.T.S.

ATTACHMENT OF BONDING LOOP TO BRIDGE PARAPET SCALE: N.T.S.

DETAIL

90% SUBMISSION 03/09/2016

STATE OF CONNECTICUT SIGNATURE/ BLOCK: **GROTON** AJM 058-332 THE INFORMATION, INCLUDING ESTIMATED QUANTITIES OF WORK, SHOWN ON THESE SHEETS IS BASED ON LIMITED INVESTIGATIONS BY THE STATE AND IS IN NO WAY WARRANTED TO INDICATE THE CONDITIONS OF ACTUAL QUANTITIES OF WORK WHICH WILL BE REQUIRED. RECONSTRUCTION OF ROUTE 349 NB AND SB **GANNETT FLEMING** WJS/WWF **BBG-07** GROUNDING & BONDING OVER AMTRAK RAILROAD **DEPARTMENT OF TRANSPORTATION ASSEMBLY DETAILS** SCALE AS NOTED SHEET 2 OF 2 REVISION DESCRIPTION REV. DATE SHEET NO. Plotted Date: 3/3/2016 Filename: ...\058_332_G&B assembly_details_Sheet_2.dgn